



5 proposed ground floor plan
scale 1 : 200


6 proposed roof plan
scale 1 : 200

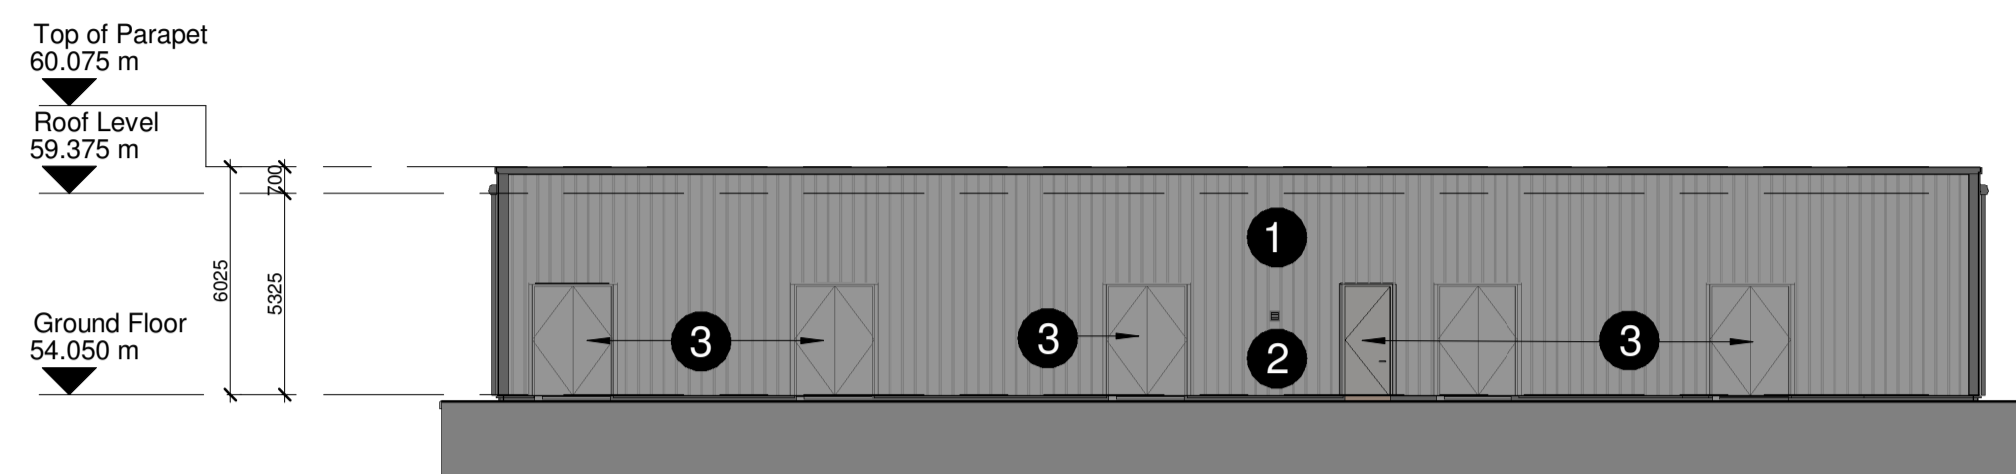


1 proposed east elevation
scale 1 : 200

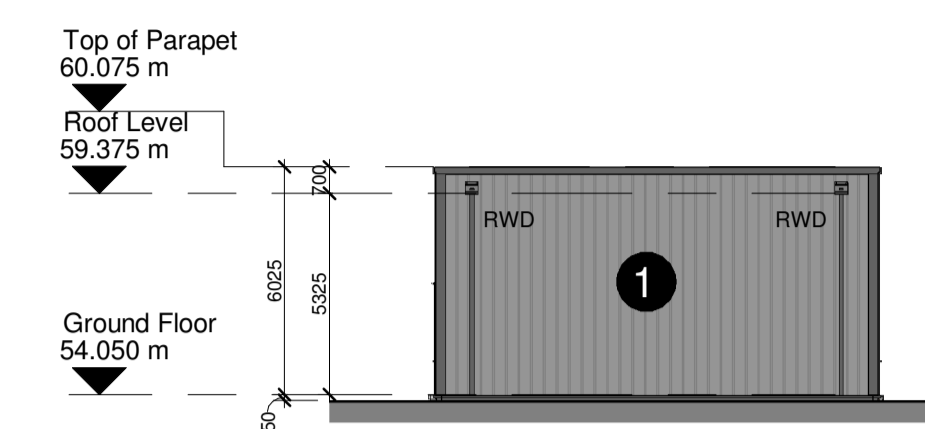


2 proposed north elevation
scale 1 : 200

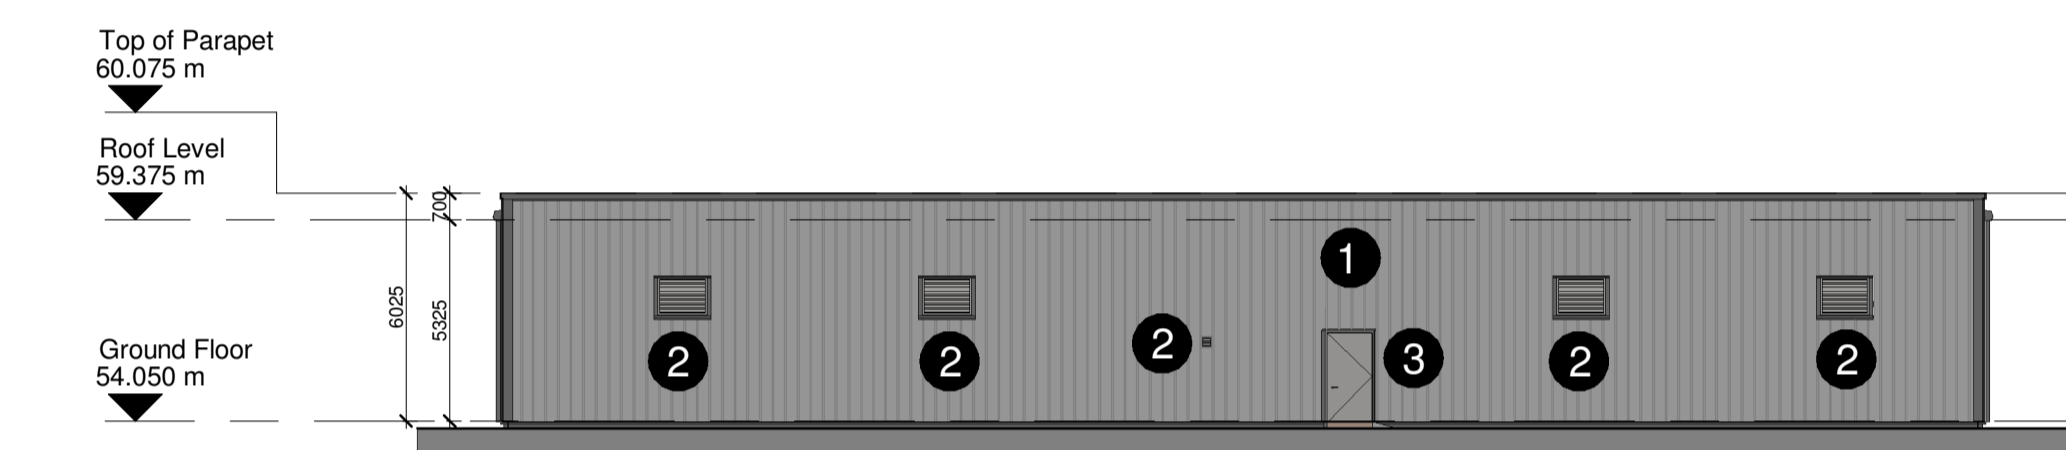


3 proposed west elevation
scale 1 : 200

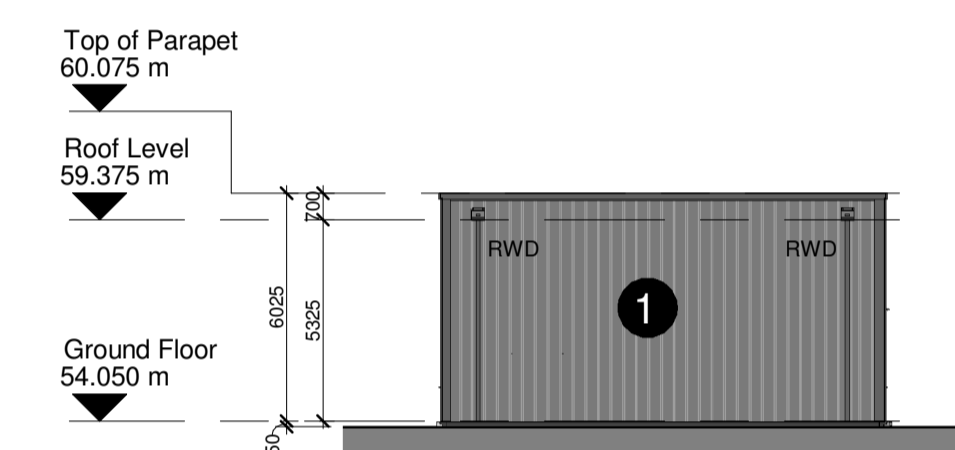

4 proposed south elevation
scale 1 : 200

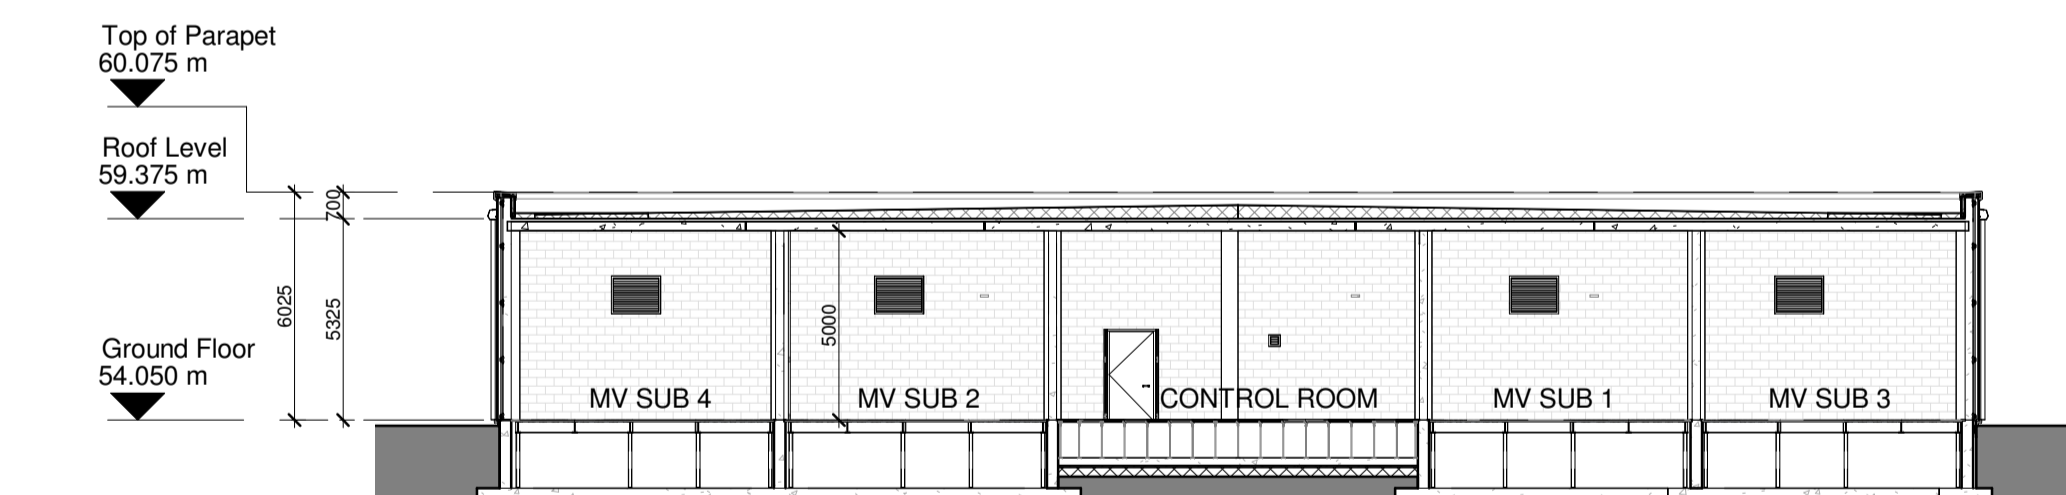

7 proposed longitudinal section
scale 1 : 200

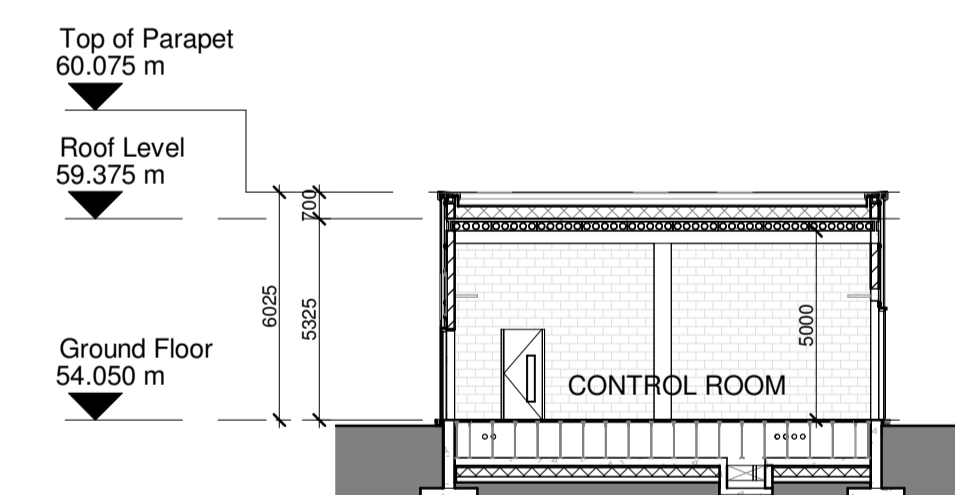

8 proposed cross section
scale 1 : 200

NOTES:

Check all dimensions on site. Do not rely on scaled dimensions. This drawing must be read in conjunction with all relevant contract documents.

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LEGEND:

— SITE SUBJECT TO PLANNING APPLICATION.

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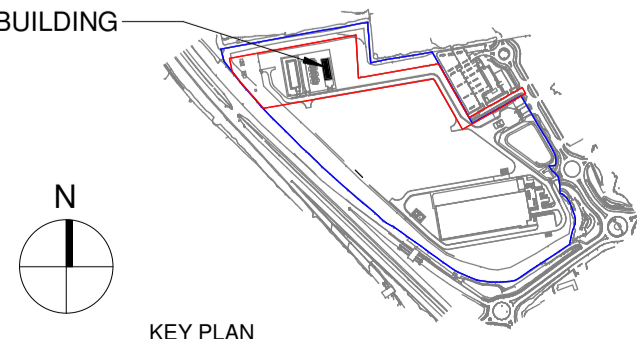
MATERIAL LEGEND:

1 SELECTED COATED METAL WALL PANEL (DARK GREY RIB PANEL) RAL COLOUR TBC

2 POWDER COATED GALVANISED STEEL LOUVRE/VENTS RAL COLOUR TO MATCH CLADDING

3 INSULATED AND GALVANIZED STEEL DOOR WITH RAL COLOUR TO MATCH CLADDING

CLIENT CONTROL BUILDING



Rev	Date	Description	Dm	Chkd
P02	13.10.20	ISSUED FOR SUBMISSION	ML	IOK

Architecture + Interior Design + Masterplanning + Project Management

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Client:	CAP DEVELOPMENTS LLC	Job No:	2020.26
Project:	OLDBRIDGE 110kV SUBSTATION	Sheet:	A1
Drawing:	CLIENT CONTROL BUILDING PLANS, ELEVATIONS & SECTIONS	Scale:	As Indicated
Stage:	PLANNING	Status Code:	S5
Status:	FOR SUBMISSION	Drawing Number:	CAP-MCA-02-XX-DR-A-1080

REVISION:

P02